


IC Goverment Center 7702-190810

NEW HANOVER COUNTY
GOVERNMENT CENTER
GOVERNMENT CENTER DRIVE
WILMINGTON, NC 28403

LS3P PROJECT: 7702-190810

[illegible]

KEY PLAN:

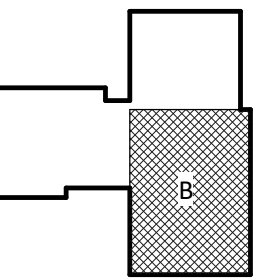

SHEET NAME:
FLOOR PLAN- LEVEL
1- AREA B

ORIG SUBMISSION: 2020.12.16

CURRENT: 2020.12.22

ADDENDUM #1


SHEET:

A-101B

GMP SET

1. DIMENSIONS TO FACE OF PARTITIONS ARE TO FACE OF STUD. FINISHES PERPENDICULAR TO PARTITION WALLS AND ELEVATIONS ARE NOT SHOWN ON PARTIAL FLOOR PLANS. REFER TO ENLARGED PLANS, ELEVATIONS AND DETAIL SHEETS FOR ADDITIONAL INFORMATION.
2. LOCATE DOOR OPENINGS "4" FROM NEAREST PERPENDICULAR WALL. PARTITION WALL AND SOUND RATED WALLS/PARTITIONS TO BE CONSTRUCTED TIGHT TO STRUCTURE, PIPING, DUCTWORK AND OTHER PENETRATIONS. ALL GAPS FULLY SEALED.
3. PARTITIONS ARE TO BE CONSTRUCTED TO THE FINISHED FLOOR DETAIL.
4. WHERE PARTITIONS OF DIFFERENT FIRE RATINGS INTERSECT, THE HIGHEST RATED PARTITION SHALL CONTINUE THROUGH. MAINTAIN PARTITION FIRE RATING BEHIND RATED PARTITION AND EXTEND TO TOP OF RATED PARTITION.
5. INSTALL BLOCKING IN PARTITIONS FOR CASEWORK, WALL MOUNTED EQUIPMENT, TRIM AND RELATED CONSTRUCTION.
6. AT ANY LOCATION WHERE AN INTERIOR WALL TERMINATES AT AN EXTERIOR W/STREETFRONT, INSTALL MEET HAVE AT INTERSECTION OF WALL AND STREETFRONT.
7. SEE LIFE SAFETY PLANS FOR REQUIRED FIRE SEPARATION WALLS.
8. SEE SHEET A-001 FOR CONSTRUCTION SUBSYSTEMS AND PARTITION SCHEDULE.
9. SEE SHEET A-70 TO A-710 FOR INTERIOR ELEVATIONS.
10. SEE SHEETS A-801 THROUGH A-814 FOR FINISH FLOORING, TRANSITIONS, PATTERNS AND WALL PROTECTION.
11. SEE SHEETS A-401 & A-402 FOR ENLARGED PLANS INDICATING ADDITIONAL DIMENSIONS AND PARTITION TYPES, ACCESSORIES AND MOUNTING HEIGHTS.
12. SEE STRUCTURAL DRAWINGS FOR PARTITION TYPES, CONNECTIONS, DETAILS, CUTOUTS, WHERE STRUCTURAL STEEL MEMBERS ARE EXPOSED AND NOT CONCEALED W/ OTHER CONSTRUCTION, PAINT FINISH TO MATCH STOREFRONT/ CURTAIN WALL FRAME SYSTEMS, ETC.
13. GYPSUM WALL BOARD ON EXTERIOR WALLS AT PART OF CORE & SHELL PLANE.
14. INSTALL PT WOOD BLOCKING IN WALLS AT ALL SCREEN LOCATIONS. SEE AV DRAWINGS.

1. ALL NON-DESIGNATED PARTITIONS SHALL BE TYPE 3A.
2. THE TACKER BOARD SHALL BE USED IN ALL LOCATIONS TO RECEIVE THE FINISHES.
3. REFER TO FINISH SCHEDULE FOR FINISHES. REFER TO FINISH SCHEDULE FOR LOCATIONS.
4. FABRICATION SHALL COORDINATE WITH MECHANICAL DUCTWORK PRIOR TO FABRICATION OF PARTITION WALLS.
5. SHOULD CONDITIONS OCCUR WHERE A WALL IS UNABLE TO GO STRAIGHT UP TO CEILING DUE TO MECHANICAL DUCTWORK, ETC., THE PARTITION GYPSUM BOARD AND FRAMING MAY JOG HORIZONTALLY ABOVE THE CEILING TO AVOID THE PROBLEM. RATED WALL INTEGRITY SHALL BE MAINTAINED.
6. WHERE STUDS EXTEND TO STRUCTURE AND GYPSUM WALLBOARD AND SOUND INSULATION BLANKET ARE REQUIRED TO COVER THE FINISH CEILING, CAP OFF PARTITION FINISHES WITH A RUNNER CHANNEL WHEN CEILING PLENUM IS USED AS A RETURN AIR PLENUM.
7. C. D. D. CONFLICTS BETWEEN PARTITION TYPES AND THE ARCHITECTS FLOOR PLANS SHALL BE BROUGHT TO THE ATTENTION OF THE ARCHITECT.
8. SEE LIFE SAFETY PLANS FOR THE LOCATIONS OF SMOKE BARRIERS, SMOKE PARTITIONS AND FIRE-RATED PARTITIONS.
9. REFER TO MECHANICAL AND PLUMBING DRAWINGS FOR FIRE RESISTANCE VOLUMES - CURRENT EDITION FOR SPECIFIC CONSTRUCTION REQUIREMENTS OF U.L. LISTED ASSEMBLIES.
10. REFER TO MECHANICAL, ELECTRICAL AND PLUMBING DRAWINGS FOR TYPICAL U.L. LISTED PENETRATIONS THROUGH FIRE-RATED ASSEMBLIES. PARTITION SHALL BE RESPONSIBLE FOR PROVIDING APPROPRIATE PROJECT-SPECIFIC U.L. LISTED ASSEMBLIES FOR PENETRATIONS.
11. REFER TO DETAIL MECH. DWGS. FOR TYPICAL WALL FRAMING FOR FIRE DAMPERS IN 100% COORDINATION WITH MECHANICAL CONTRACTOR AND MECHANICAL MANUFACTURER. (COORDINATE ALL PARTITION CONSTRUCTION WITH MECHANICAL PRIME CONTRACTOR PRIOR TO COMMENCING PARTITION CONSTRUCTION).

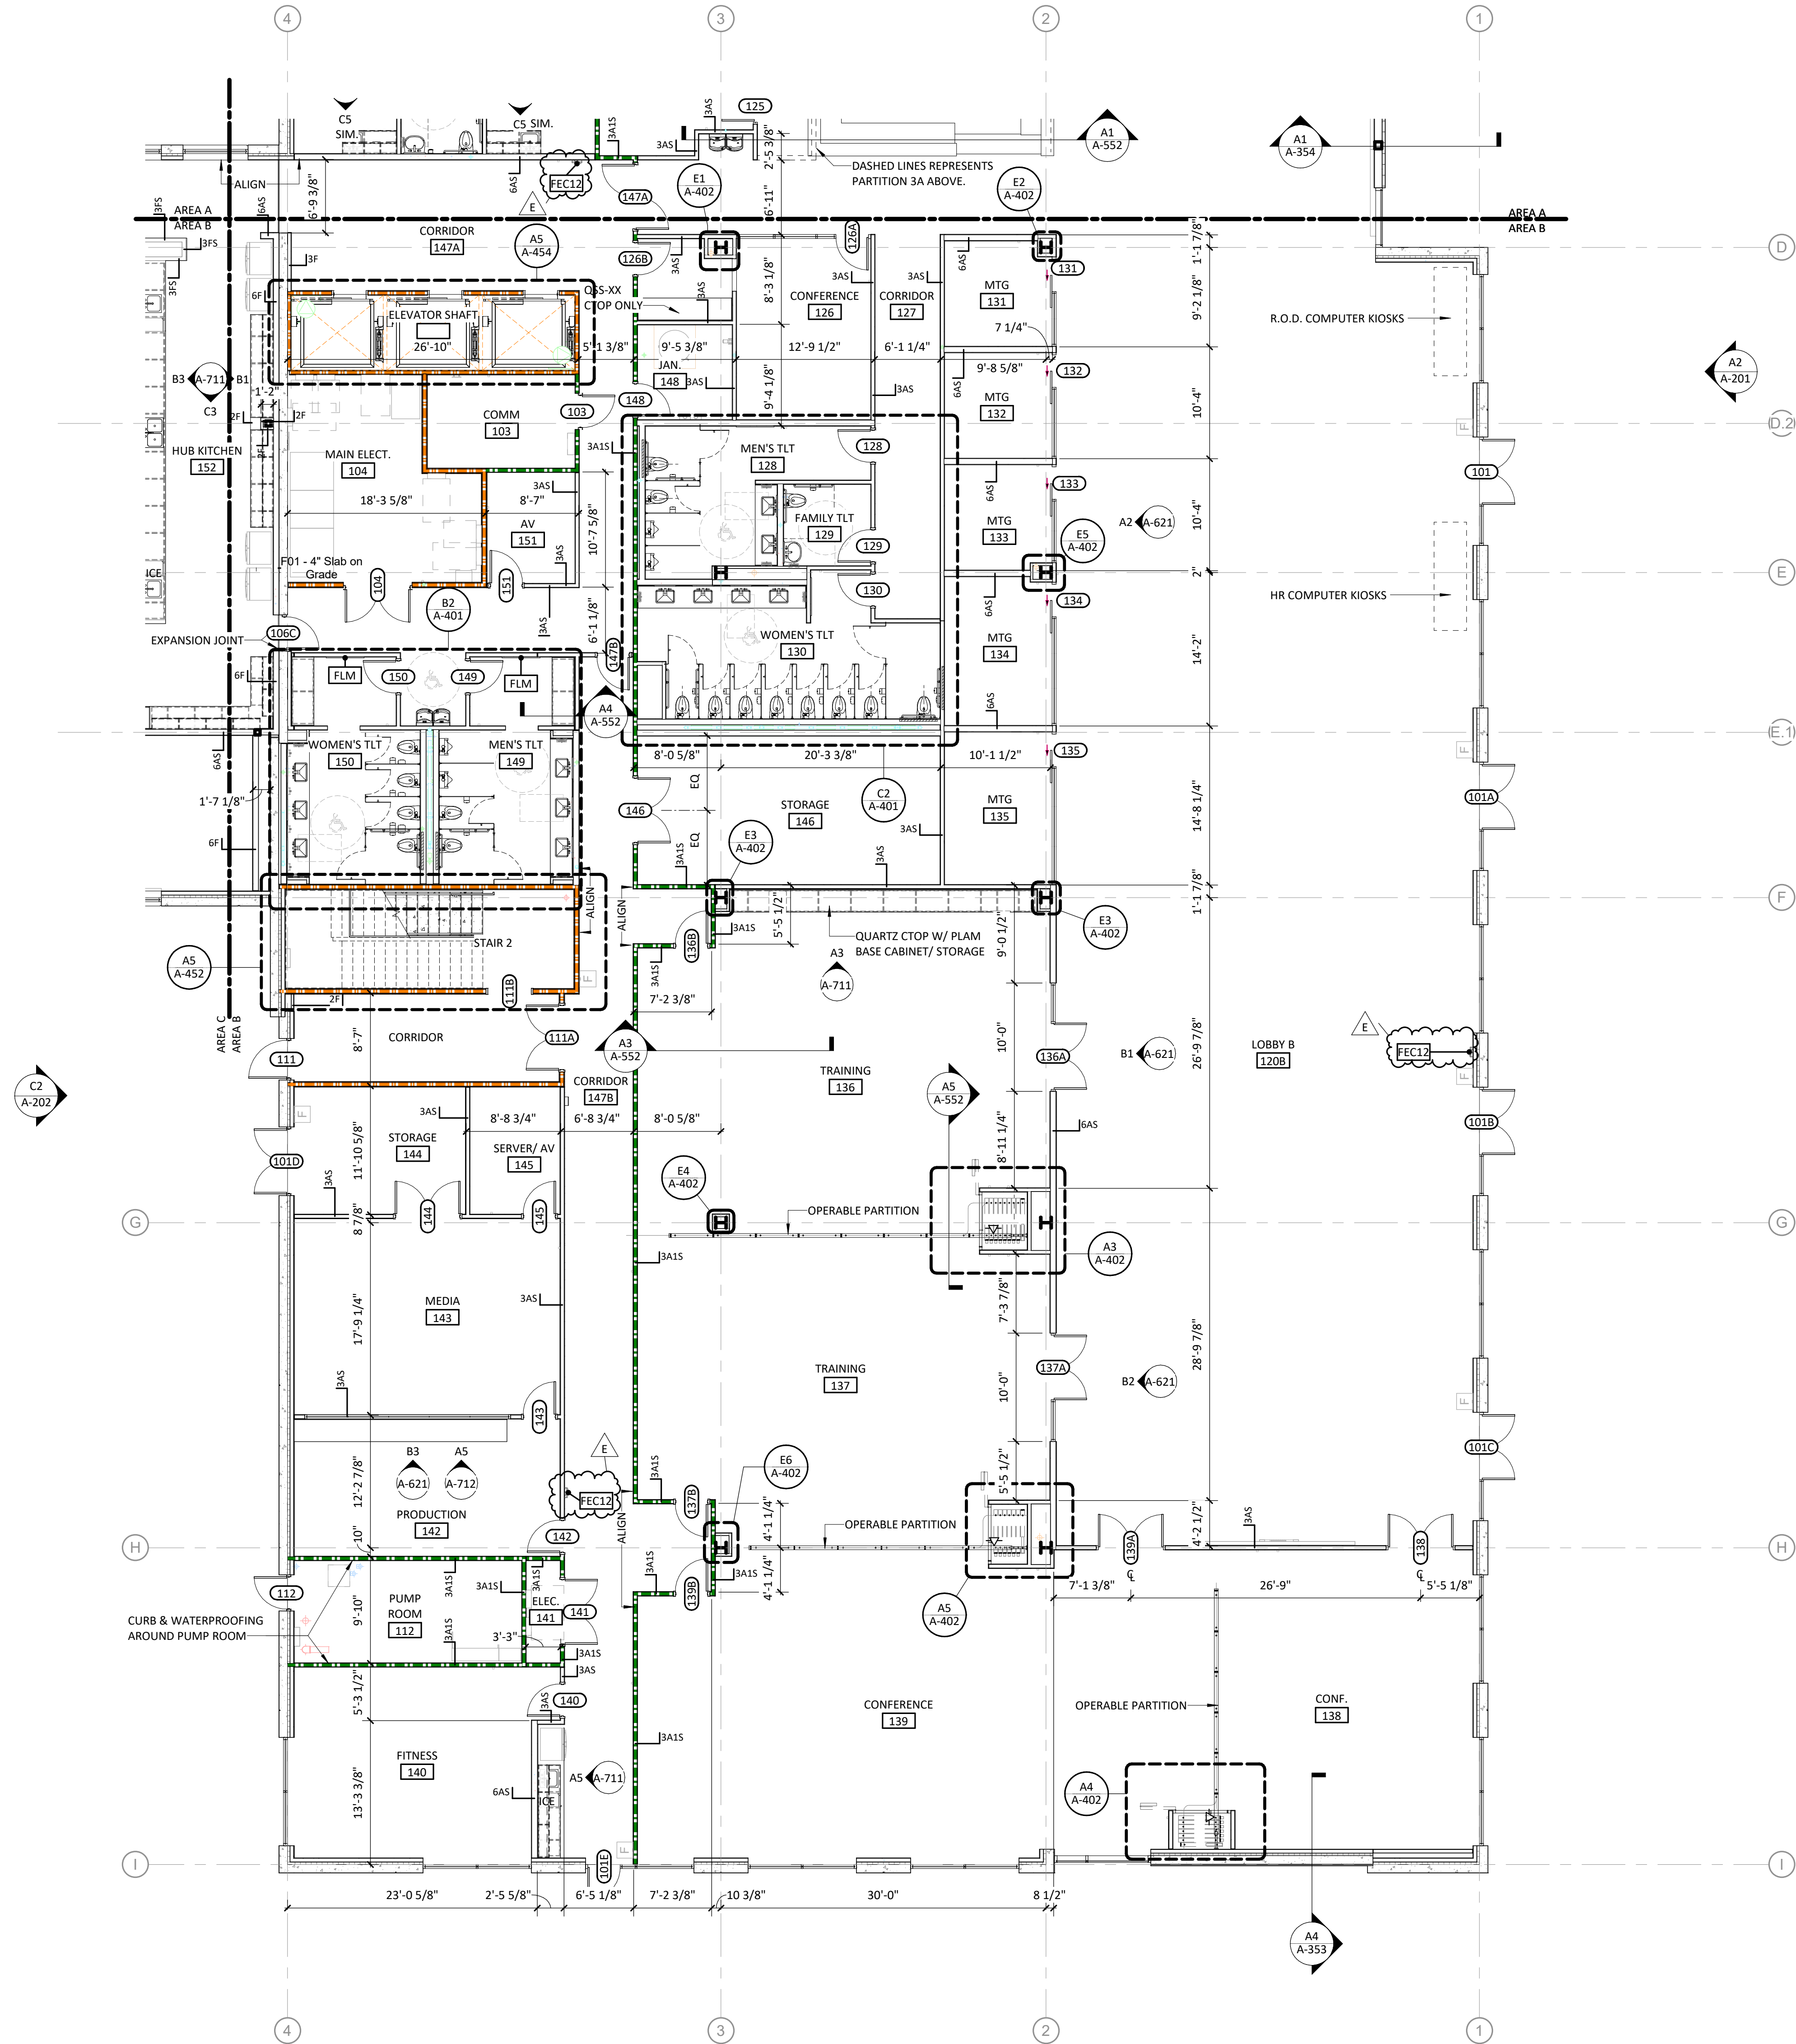

A1 A-101B	FLOOR PLAN- PARTIAL- LEVEL 1- AREA B	1/8" = 1'-0"
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